

SOUTH (FRONT) ELEVATION  
*Showing Proposed Two Bay Extension*  
*Scale 3/4" = 1'-0"*

ELECTRICAL SECTION  
**FILE COPY**  
 1152  
 Nav-950

6P-1795

GOVERNMENT CONTRACT NO. C NAV-950


DRAWING No.	REFERENCES	DRAWING No.	REFERENCES	No.	REVISIONS	BY	DATE	No.	REVISIONS	BY	DATE	APPROVED	DRAWING NUMBER	THE RUST ENGINEERING CO.	PROPOSED SOUTH ELEVATION ELECTRIC GENERATING PLANT
													EP-1795	PITTSBURGH, PA.	ADVISORY COMMITTEE FOR AERONAUTICS LANGLEY FIELD • HAMPTON VIRGINIA

**MAQ107**

ORIGINALS HAVE NOT BEEN SUBMITTED TO ENG. DRAWING FILES. COPIES CLIPPED FROM ARCHITECTURAL CONTRACT FILES. BOOK IN BEST QUALITY.

L D, 009, 794



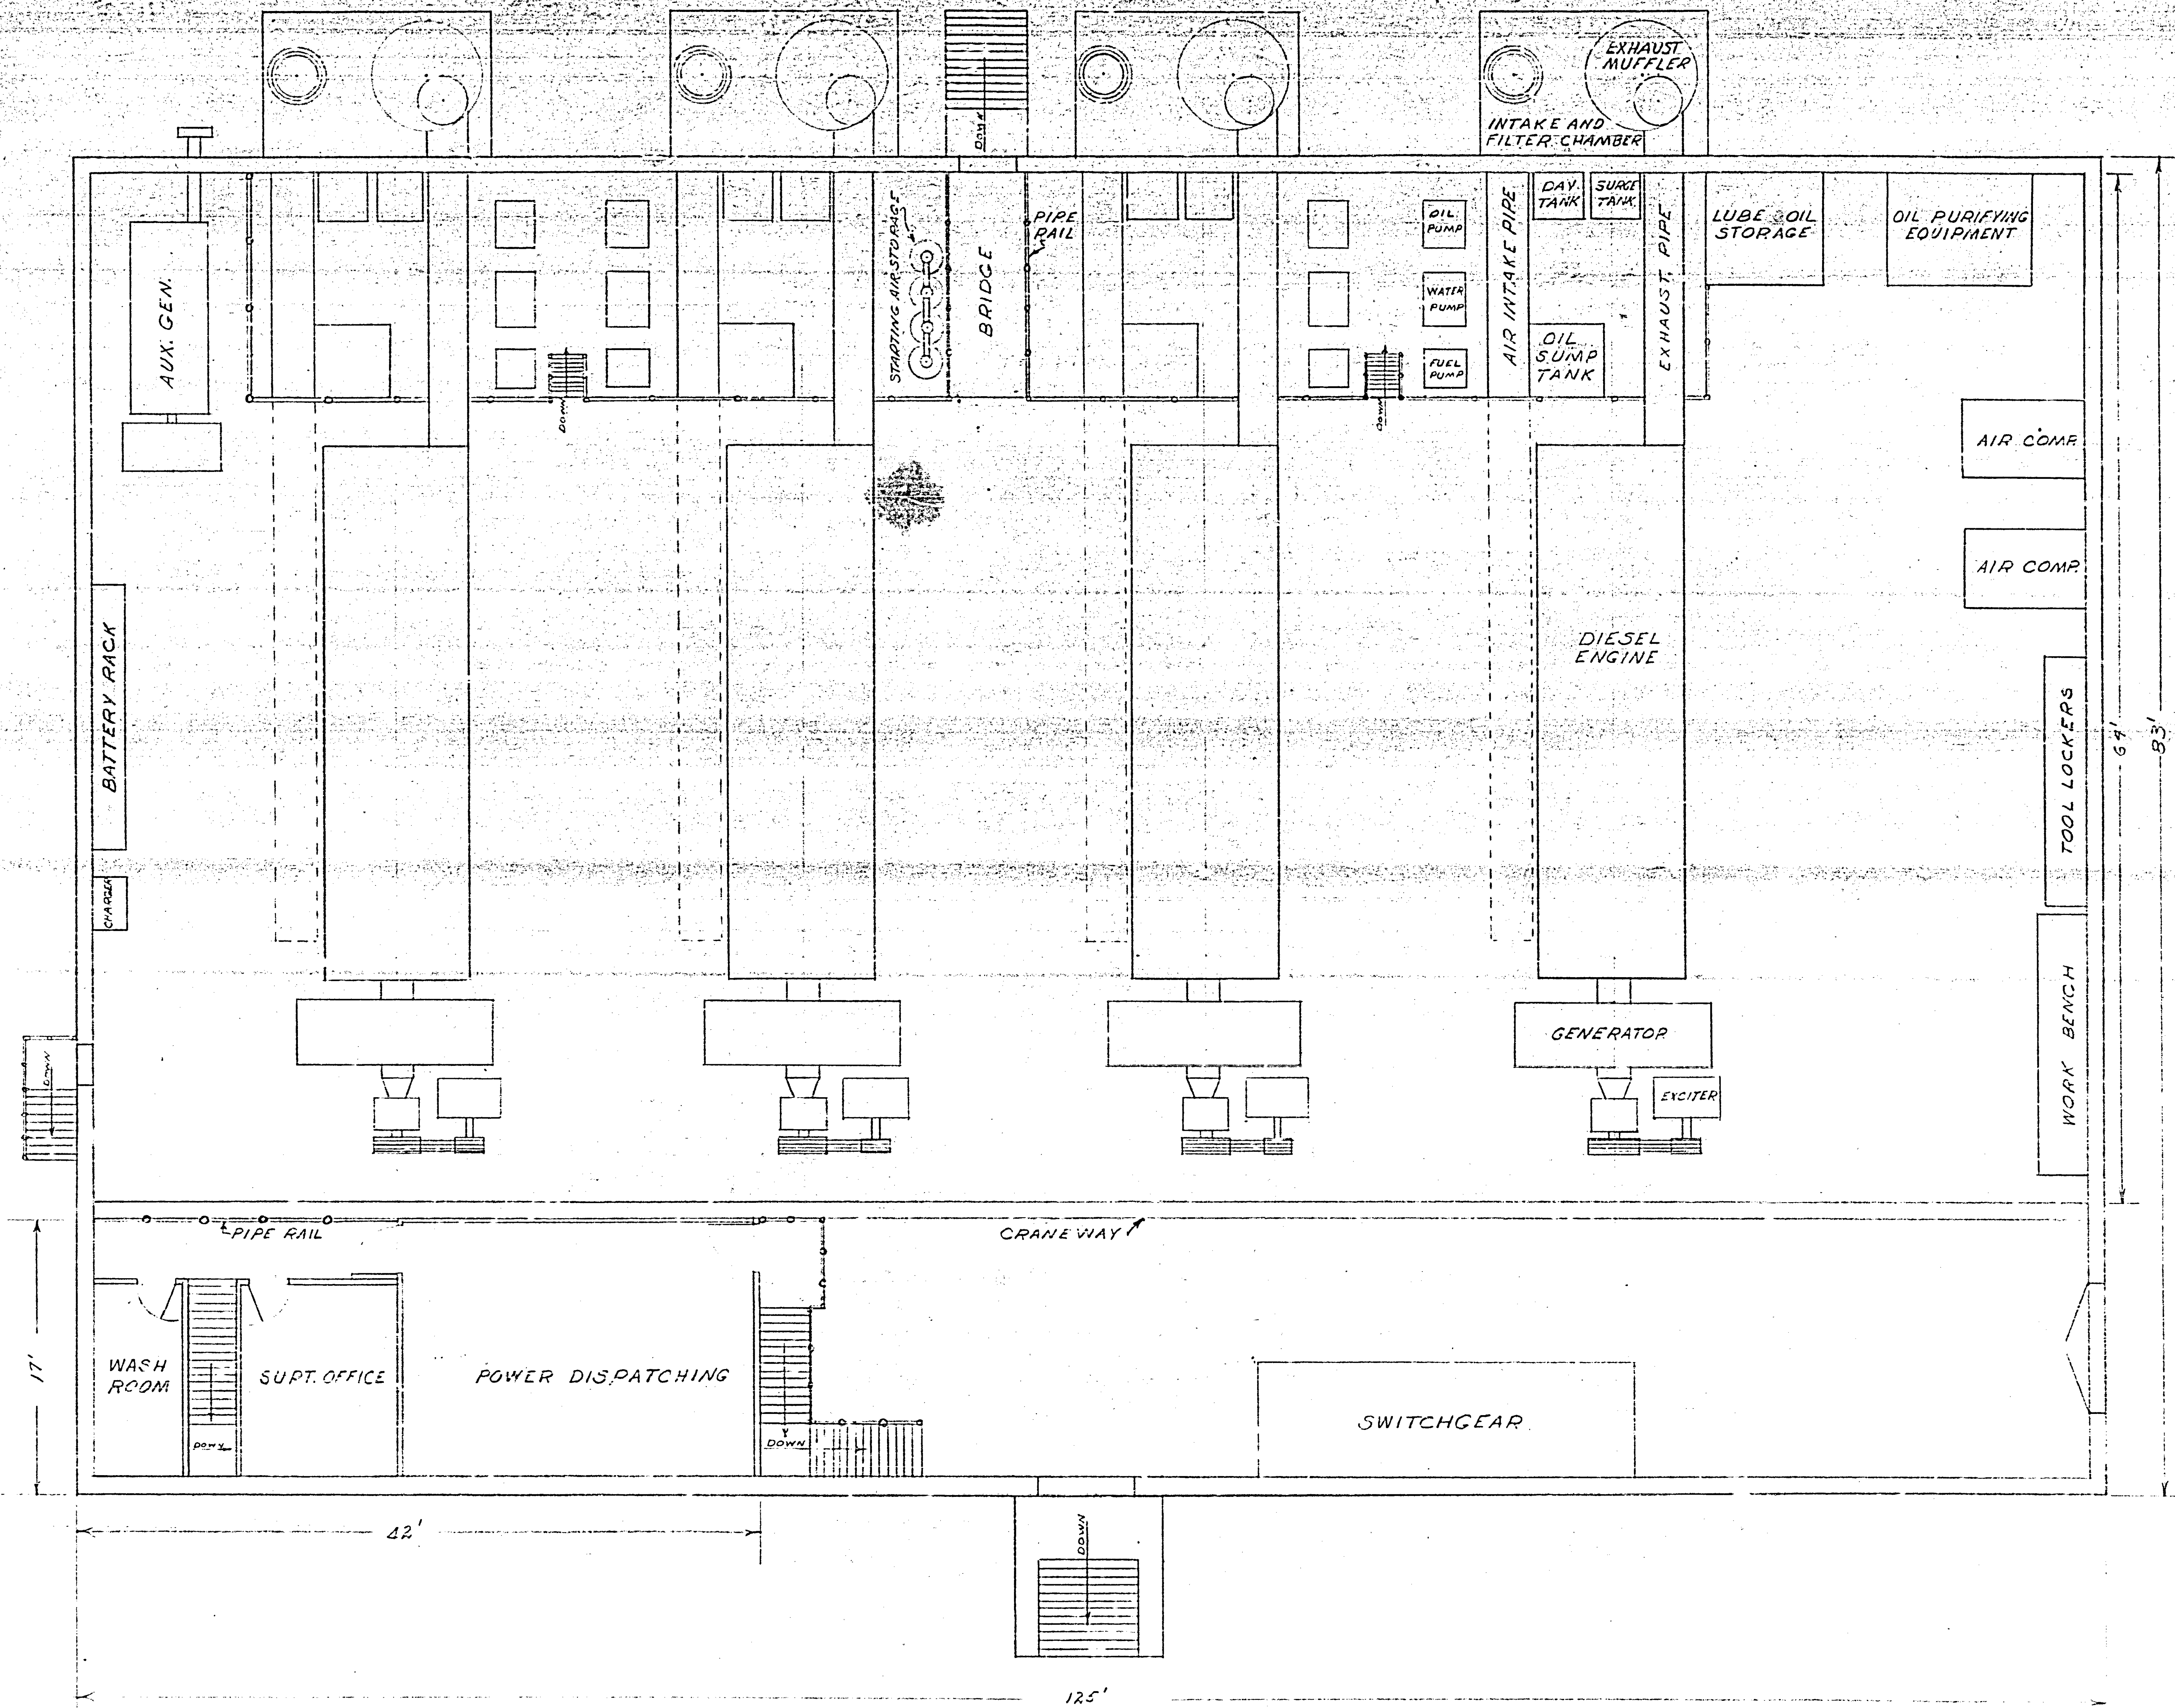


TENTATIVE LAYOUT FOR  
GENERATING PLANT-PLAN

NATIONAL ADVISORY COMMITTEE FOR AERONAUTICS  
RESEARCH LABORATORY - LANGLEY FIELD, VA.

E	A	DR	D-7673
F	B	CK	23 SHEETS
G	C	AP	
H	D	AP	

MICROFILMED  
MAY 1950



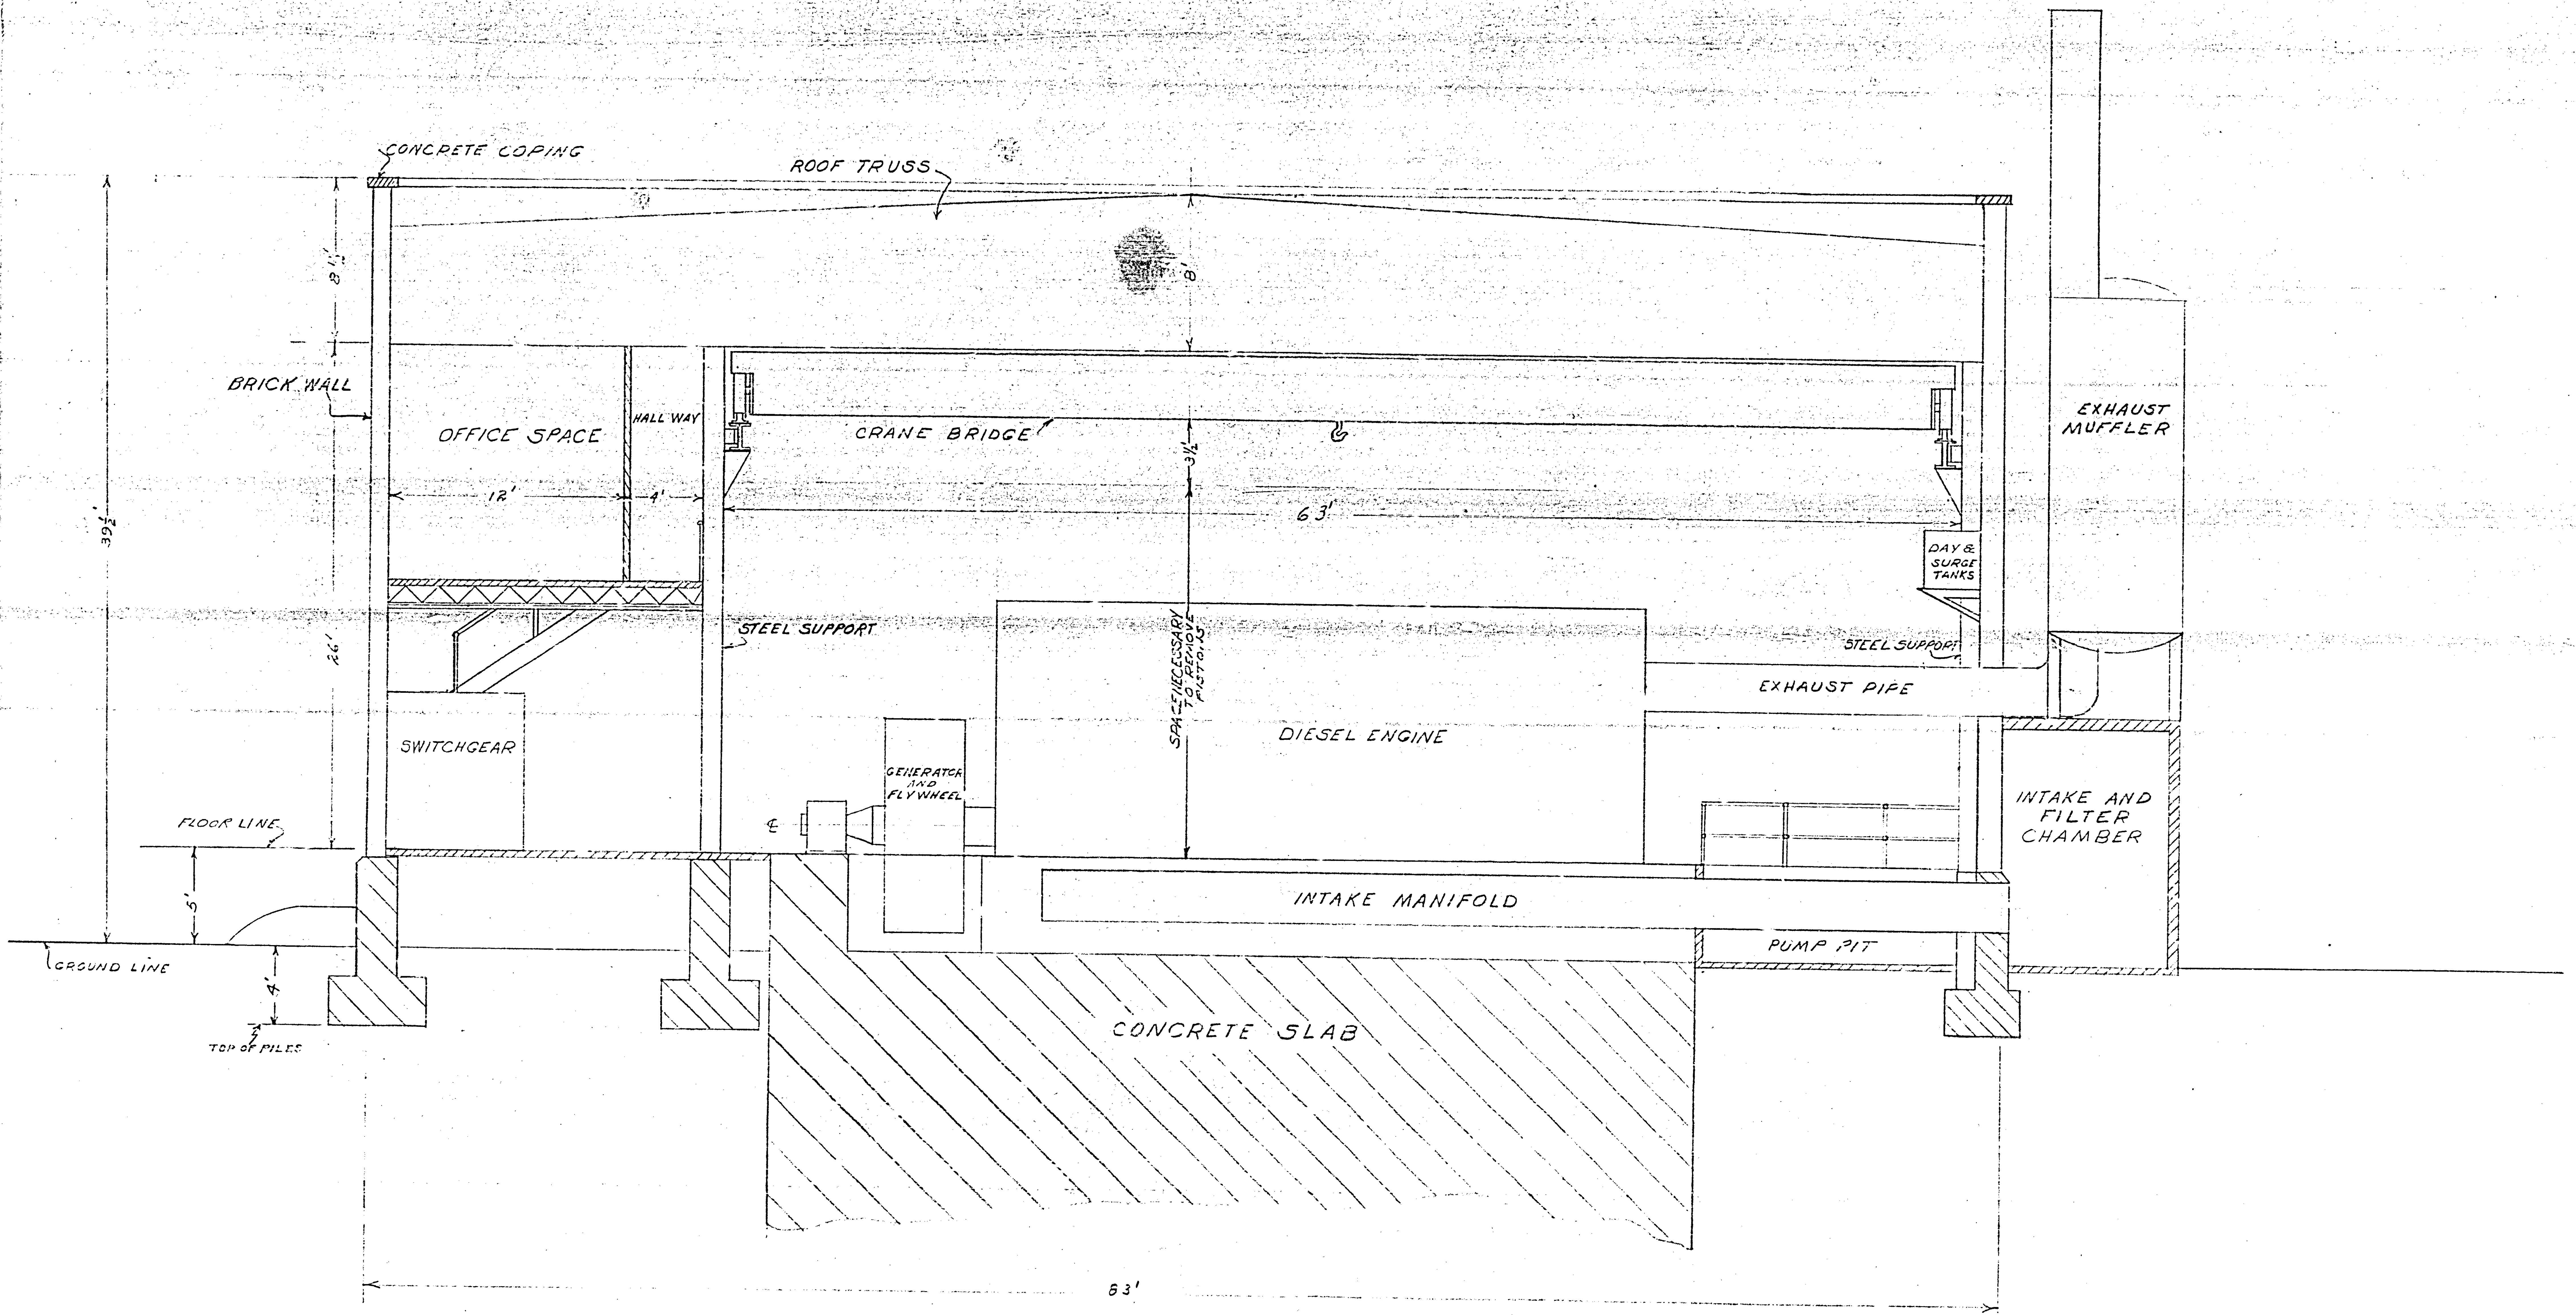


TENTATIVE LAYOUT FOR  
 GENERATING PLANT - ELEY  
 NATIONAL ADVISORY COMMITTEE FOR AERONAUTICS  
 RESEARCH LABORATORY - LANGLEY FIELD, VA.

E	A	DR	11/22/22	40
P	B	CK		
G	C	AP	11/22/22	254
H	D	AP		


NOV 1950



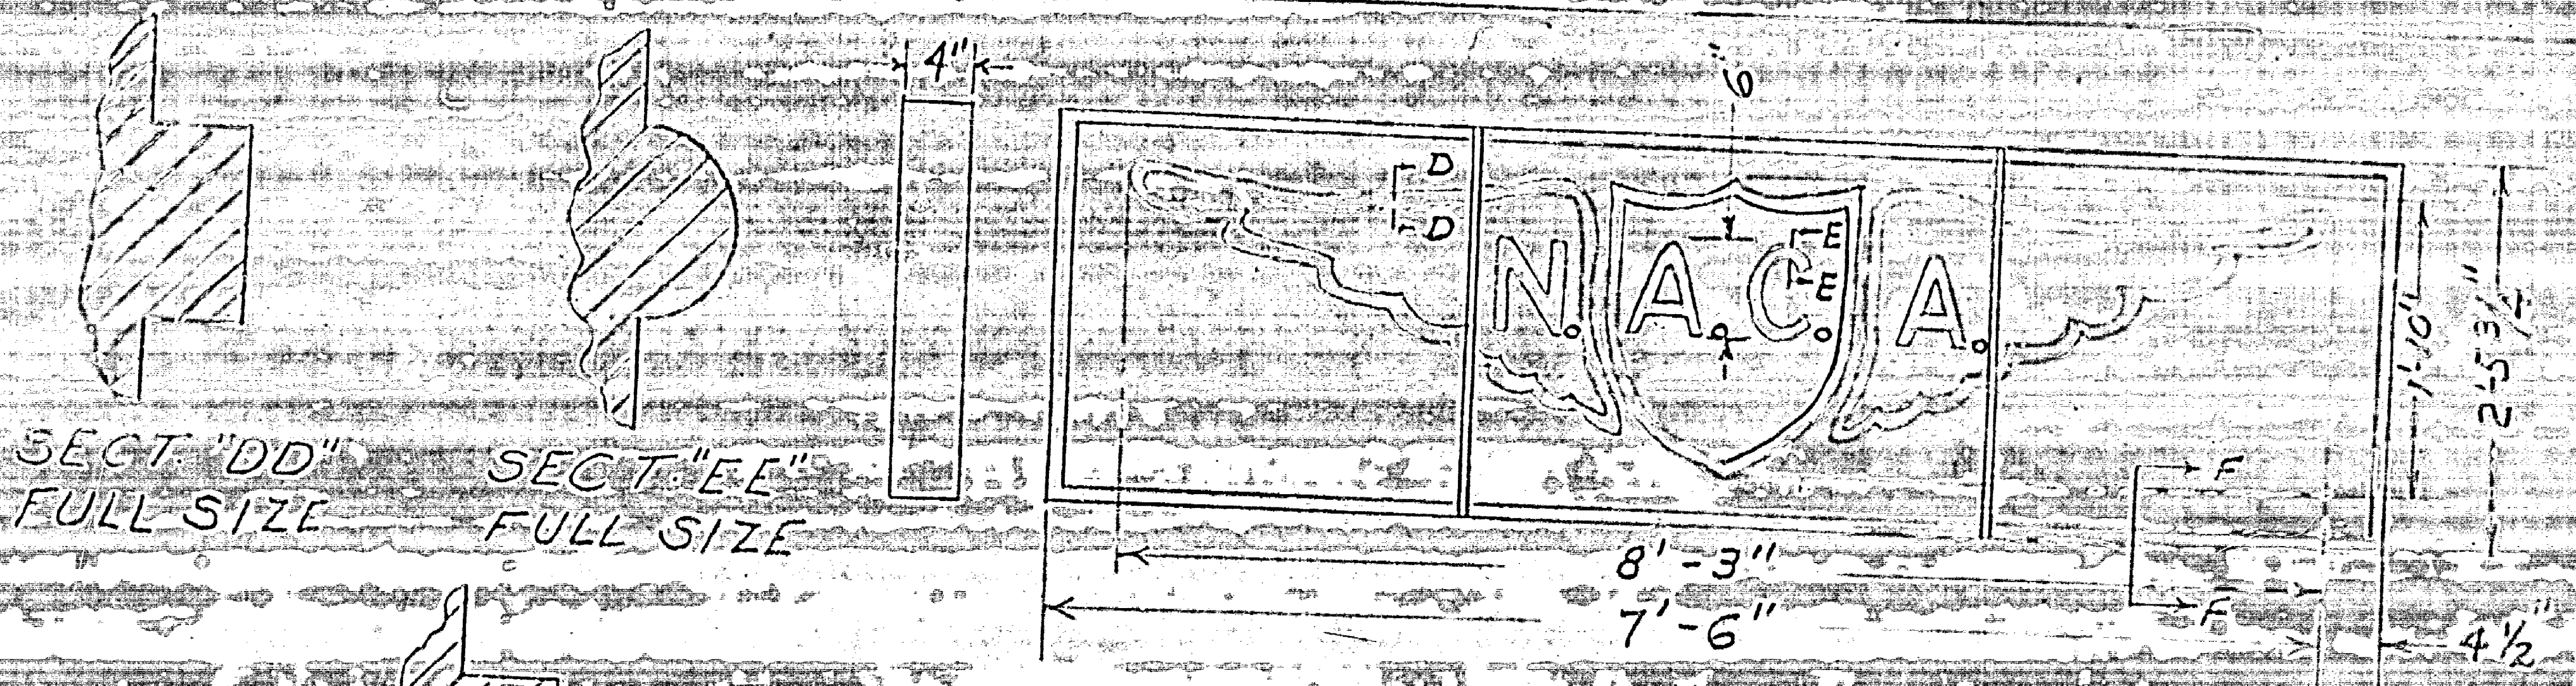


SECT "DD"  
FULL SIZE

SECT "EE"  
FULL SIZE

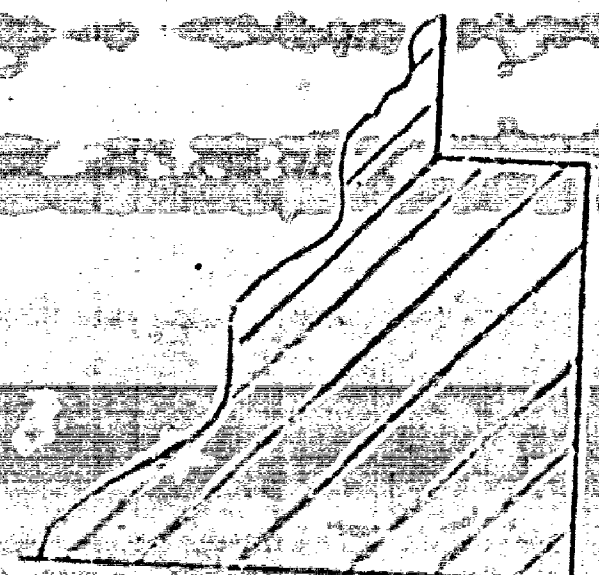


SECT "FF"  
FULL SIZE

MATERIAL LIMESTONE - 1 REQ'D.

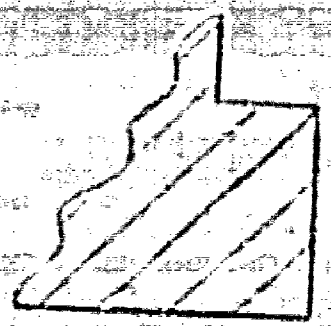

SECT. THRU LETTERS  
FULL SIZE

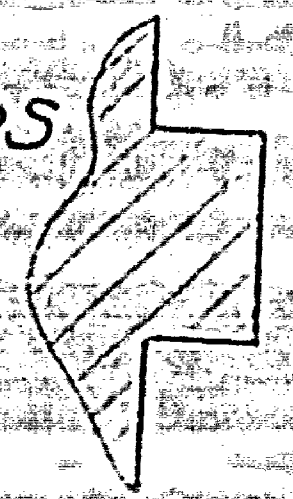

SECT. THRU BORDER  
FULL SIZE

LINTEL STONE & INSIGNIA  
FOR GENERATING PLANT

NATIONAL ADVISORY COMMITTEE FOR AERONAUTICS  
RESEARCH LABORATORY — LANGLEY FIELD, VA.

E	A	DR - R.N.B. - 8-17-44
F	B	CK -
G	C	AP -
H	D	AP - G.T.C. - 8-17-44

A-7674